Generated by RES*check-Web* Software **Compliance Certificate**

65 troy rd Project

Energy Code 2021 IECC Location: Millburn, New Jersey Construction Type: Single-family Project Type: Addition 4 (5894 HDD) Climate Zone: Permit Date:

Permit Number:

Construction Site: Owner/Agent: Designer/Contractor: 65 troy rd Mansoor Azizi Millburn, nj 07041 1218 warren way Wanaque, nj 07465 9737230039

ompliance: Passes using UA trade-off

Maximum UA: **182** Your UA: **181** Maximum SHGC: **0.40** Your SHGC: **0.40** The % Better or Worse Than Code Index reflects how close to compliance the house is based on code trade-off rules. It DOES NOT provide an estimate of energy use or cost relative to a minimum-code home.

Slab-on-grade tradeoffs are no longer considered in the UA or performance compliance path in REScheck. Each slab-on-grade assembly in the specified climate zone must meet the minimum energy code insulation R-value and depth requirements.

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Envelope Assemblies

Assembly	Gross Area or Perimeter	Cavity R-Value	Cont. R-Value	Prop. U-Factor	Req. U-Factor	Prop. UA	Req. UA
Ceiling 1: Flat Ceiling or Scissor Truss	625	60.0	0.0	0.024	0.024	15	15
Wall 1: Wood Frame, 16" o.c.	392	21.0	0.0	0.057	0.045	13	10
Door: 3'0" X 6'8"-Glazed LE Copy: Glass Door (over 50% glazing) SHGC: 0.40	80			0.300	0.300	24	24
Window: 3'0" X 5'0" LE Copy: Wood Frame SHGC: 0.40	90			0.300	0.300	27	27
Wall 2: Wood Frame, 16" o.c.	872	21.0	0.0	0.057	0.045	41	32
Window: 3'0" X 5'0" LE: Wood Frame SHGC: 0.40	150			0.300	0.300	45	45
Floor 1: All-Wood Joist/Truss, Over Unconditioned Space	285	38.0	0.0	0.026	0.047	7	13
Floor 2: All-Wood Joist/Truss, Over Outside Air	340	38.0	0.0	0.026	0.047	9	16


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Additional Efficiency Package(s)

Compliance Statement: The proposed building design described here is consistent with the building plans, specifications, and other calculations submitted with the permit application. The proposed building has been designed to meet the 2021 IECC requirements in REScheck Version: REScheck-Web and to comply with the mandatory requirements listed in the REScheck Inspection Checklist.


Name - Title

PROPOSED ADDITION AND ALTERATION EXISTING SINGLE FAMILY HOUSE 65 TROY ROAD, LOT#6, BLOCK 4505, MILLBURN TOWNSHIP, ESSEX COUNTY, NJ, 07041

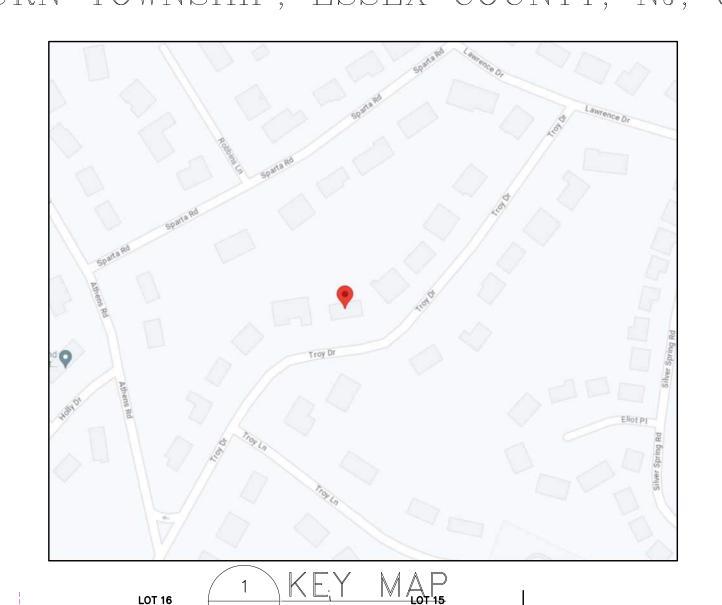

Rebar w/cap Found "Casey & Keller"

N 69°05'30" E 78.00'

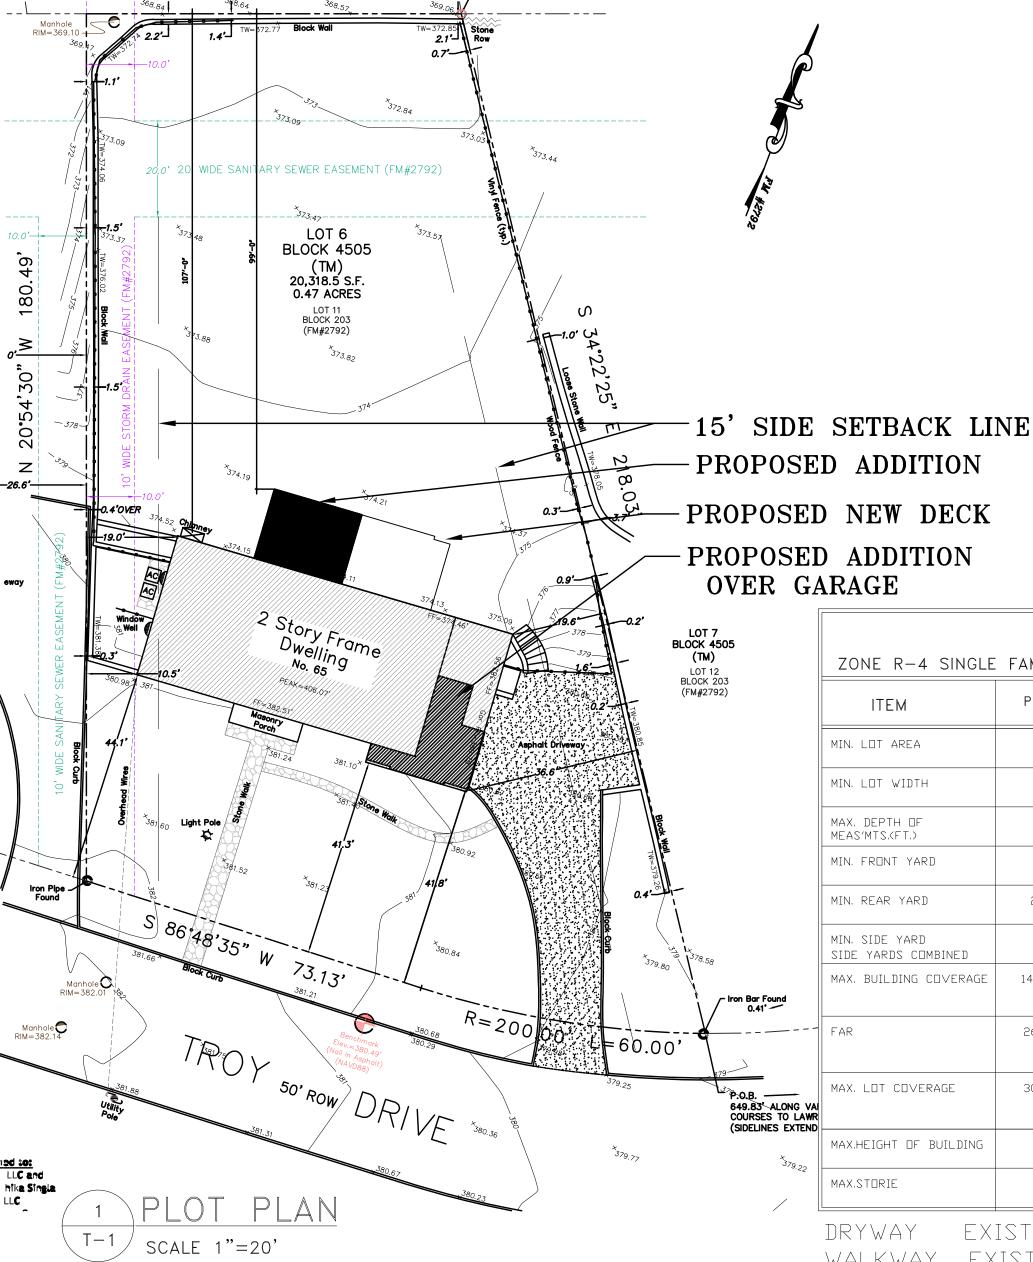

A.C. AIR CONDITIONING NEW CONC. BLOCK WALL AD.J ADJACENT C.G. CORNER GUARD FULL HEIGHT PARTITION ALUM, ALUMINUM NEW FULL HEIGHT PARTITION ALUM.S. ALUMINUM SADDLE DET. DETAIL DIA. DIAMETER EXIST, WALLS TO BE REMOVED APPROX. APPROXIMATE DIM. DIMENSION INTERIOR ELEVATION ARROW (SEE DETAIL NO./DWG.NO.) ARCH. ARCHITECTURE DN. DOWN A.D. AREA DRAIN DWG. DRAWING SECTION ARROW (SEE DETAIL NO./DWG.NO.) DETAIL (SEE CORRESPONDING SHEET) B.M. BEAM SPECIFICATION ITEM (SEE EQUIPMENT SCHEDULE) BET. BETWEEN B.P.S BENT PLATE BLK. BLOCK DRAWING LIST B.S.&A BOARD OF STANDARDS & APPEALS T-1 COVER SHEET. A-1 FINISHED BASEMENT, BOTT. BOTTOM A-2 FIRST FLOOR PLAN B.O.C. BOTTOM OF CURB A-3 SECOND FLOOR PLAN, ROOF PLAN. BLDG, BUILDING A-4 FRONT, RIGHT SIDE ELEVATIONS. A-5 REAR AND LEFT SIDE ELEVATION. A-6 ELECTRIC PLANS. PLUMBING & GAS RISERS CAP. CAPACITY DIAGRAMS. CLNG. CEILING A-7 EXISTING PLANS. CEM. CEMENT D-1 GENERAL DETAILS. CENTER LINE C.T. CERAMIC TILE CLOSET DESIGN LOADS COL. COLUMN LIVE LOADS - ROOFS SNOW LOAD AT SHELTERED ROOF = 50 PSF SNOW LOAD AT SLOPED ROOFS = 30 PSF EXCEPT AS NOTED CONC. CONCRETE LIVE LOADS - FLOORS

ALL AREAS NOT OTHERWISE NOTED = 40 PSF C.B. CONCRETE BLOCK F.J. FLOOR JOISTS RESIDENTIAL BALCONIES = 60 SPF BEDROOMS = 40 PSF COND. CONDUIT F.D. FLOOR DRAIN CONST. CONSTRUCTION F.V. FIELD VERIFY EARTH QUAKE LOADS = 5% OF DEAD WEIGHT CONT. CONTINUOUS STANDARDS AND GENERAL NOTES CODES, REGULATIONS, PERMITS AND FEES
ALL WORK SHALL CONFORM TO THE CURRENT EDITION OF THE UNIFORM CONSTRUCTION CODE OF
THE STATE OF NEW JERSEY INCLUDING ALL SUB CODES AND REFERENCED STANDARDS. UNLESS
OTHERWISE INDICATED ALL WORK SHALL ALSO CONFORM TO THE REGULATIONS OF LOCAL UTILITY OMPANIES AND MUNICIPAL LAWS AND REGULATIONS. IF THE CONTRACT DOCUMENTS DEVIATE IN ANY WAY FROM THESE LAWS AND REGULATIONS THE CONTRACTOR / OWNER SHALL IMMEDIATELY INFORM THE ARCHITECT. THE CONTRACTOR SHALL BE RESPONSIBLE FOR OBTAINING AND PAYING FOR ALL REQUIRED PERMITS, INSPECTIONS AND CERTIFICATES NECESSARY TO CONFORM TO LAWS AND REGULATIONS. PRECEDENCE OF CONTRACT PROVISIONS
IF ANY CONFLICTS EXIST IN THE CONTRACT DRAWINGS THEY SHALL BE RESOLVED IN THE ORDER
OF PRIORITY LISTED BELOW WITH THE HIGHEST PRIORITY LISTED FIRST ON THE LIST. WORK OR
MATERIALS SHOWN ON ONE OR MORE LOCATIONS BUT NOT IN ALL SIMILAR LOCATIONS SHALL BE
DEEMED TO SHOW IN ALL SIMILAR CONDITIONS AND NOT TO SHOW IN ALL SIMILAR CONDITIONS AND NOT TO SHOW IN ALL SIMILAR CONDITIONS AND NOT TO AN CONFLICTS OR OMISSION. GENERAL NOTES AND STANDARDS ABOVE ALL OTHER PROVISIONS DIMENSIONS GIVEN IN NUMBERS ABOVE SCALED DIMENSIONS 3. INFORMATION PROVIDED IN SCHEDULES AND TABLES ABOVE DETAILS & NOTES.
4. LARGE SCALE DRAWINGS OVER SMALLER SCALED DRAWINGS. SAFETY AND INDEMNIFICATION
THE CONTRACTOR SHALL BE SOLELY RESPONSIBLE FOR CONSTRUCTION MEANS, METHODS,
TECHNIQUES, SEQUENCES AND PROCEDURES REQUIRED FOR THE SAFE EXECUTION AND
COMPLETION OF THE WORK. THIS PROVISION INCLUDES PROTECTION OF ADJACENT PROPERTIES.
THE CONTRACTOR SHALL CAREFULLY INVESTIGATE EXISTING CONDITIONS IN THE EXISTING STRUCTURE(S) ON OR NEAR THE BUILDING SITE, INCLUDING DEPTH OF EXISTING FOOTINGS ON AND OFF THE SITE. THE CONTRACTOR SHALL PROVIDE AND MAINTAIN ANY AND ALL NECESSARY BARRICADES, WARNING SIGNS, BRACING, SHORING, AND UNDERPINNING OF FOOTINGS AND FOUNDATIONS OF ADJACENT PROPERTIES. SHOULD THERE BE ANY SUBSTANDARD AND OR ADVERSE CONDITION FOUND DURING THE DEMOLITION OR CONSTRUCTION PROCESS, THE CONTRACTOR SHALL IMMEDIATELY NOTIFY THE ARCHITECT / ENGINEER. WHERE "VERIFY EXISTING CONDITION,..." OR "VERIFY IN FIELD" (V.I.F.) IS NOTED ON PLANS OR DETAILS THE CONTRACTOR NEEDS TO VERIFY THAT THE EXISTING CONDITIONS CONFORM TO SPECIFIED CRITERIA. THE CONTRACTOR MUST NOTIFY THE ARCHITECT, THE OWNER AND THE CODE ENFORCEMENT OFFICIAL WHERE EXISTING CONDITIONS DEVIATE FROM THE SPECIFIED CRITERIA. THE CONTRACTOR AND HIS SUBCONTRACTORS SHALL OBTAIN AND PAY FOR WORKMEN'S COMPENSATION INSURANCE. TO THE FULLEST EXTENT POSSIBLE THE CONTRACTOR SHALL INDEMNIFY AND HOLD HARMLESS THE OWNER AND ARCHITECT FROM AND AGAINST ALL CLAIMS LOSSES AND EXPENSES ATTRIBUTABLE TO PROPERTY DAMAGE OR BODILY INJURY OR SICKNESS OR DISEASE OR DEATH DUE TO INJURY TO OR TO DESTRUCTION OF TANGIBLE PROPERTY INCLUDING LOSS OF USE THEREOF OR AUTOMOBILE RELATED DAMAGE AND / OR INJURY. SAFETY PRECAUTIONS AND PROGRAMS IN CONNECTION WITH THE WORK. THE CONTRACTOR SHALL PROVIDE ALL THE NECESSARY DEVICES AND EQUIPMENT FOR SAFETY, ACCIDENT PREVENTION AND LIST OF SHOP DRAWINGS REQUIRED: 1) HVAC SYSTEMS: -HVAC CONTRACTOR TO PROVIDE DESIGN AND INSTALLATION OF ENTIRE HVAC SYSTEMS. ZONING TABLE PERMITED EXISTING PROPOSED 20.000 S.F. 20,318.5 S.F. 55,321 S.F. FRONT ± 132', REAR 78' 100′ FRONT ± 132', REAR 78' 150′ LEFT 180.49', RIGHT 218.03 40′ 41.3′ 41.3′ 86.2'+451.14' 69.9′+451.14′ 25% Lot Depth

SYMBOLS & MATERIALS

EXIST, CONC. BLOCK WALL

AC.T ACOUSTIC TILE

ZONE R-4 SINGLE FAMILY MILLBURN NJ ESSEX COUNTY ITEM MIN. LOT AREA MIN. LOT WIDTH MAX. DEPTH OF MEAS'MTS.(FT.) MIN. FRONT YARD MIN. REAR YARD MIN. SIDE YARD EXISTING LEFT 10.5', RIGHT 19.6' EXISTING LEFT 10.5', RIGHT 19.6' SIDE YARDS COMBINED MAX. BUILDING COVERAGE 14% OF LOT AREA 2,844.59 S.F. 2,345 S.F. 2,630 S.F. 20% 26% OF LOT AREA 3,514 S.F. 4,139 S.F. MAX. LOT COVERAGE 30% OF LOT AREA 4,445 S.F. 4,730 S.F. MAX.HEIGHT OF BUILDING 30'-5" 30'-5" MAX.STORIE 2 1/2

EXISTING 1509 S.F WALKWAY EXISTING 306 S.F PROPOSED DECK 285 S.F. TOTAL AREA 2100 S.F

HOLLOW METAL T.C.&R. TOWEL CABINET & RECEPTICAL EA. EACH HDR. PANEL HORIZONTAL ELEC. ELECTRIC P.H. PAPER HOLDER HDUR TREAD EL. ELEVATION PART. PARTITION TYPICAL ENCL. ENCLOSURE P.A. PLACE DE ASSEMBLY INSIDE DIMENSION EQ. EQUAL INSUL. PLATE INSULATI□N UNLESS OTHERWISE NOTED EQUIP, EQUIPMENT INTERIOR EST. ESTABLISHED REFL. REFLECTIVE VERT. VERTICAL EXIST. EXISTING REINF. REINFORCED V.I.F. JOINT VERIFY IN FIELD EXP.JT. EXPANSION JOINT REQ'D REQUIRED EXT. EXTERIOR RISER LAV. LAVATORY WATER CLOSET EXT.GR. EXTERIOR GRADE ROOF DRAIN LOW POINT WATER PROOFING EXTR. EXTRUDED ROOM WATER RESISTANT MACH. MACHINE WIDTH S.N.D. MARBLE SADDLE DISPENSER WITH F.P. FIRE PROOF MAT'L S.N.V. MATERIAL WITHOUT SECT. F.P.S.C. FIRE PROOF SELF CLOSING MAX. VENDOR MAXIMUM FLSH'G. FLASHING MECH. SIM. SECTION MECHANICAL FL. FLOOR S.S. SIMILAR METAL ST.PIPE STAINLESS STEEL MIN.

MULL, MULLION

N.T.S. NOT TO SCALE

D.C. DN CENTER

OPPOSITE

O.D. OVERFLOW DRAIN

S.P. STAND PIPE

STL. STAND POINT

STEEL SADDLE

STL.S. STEEL

OPNG. OPENING

□PP.

MASONRY OPENING

STRUC. STRUCTURE

SUSP. SUSPENDED

SWBD. SWITCH BOARD

SWGR. SWITCH GEAR

TEL. TELEPHONE

T.O.C. TOP OF CONCRETE

T.O.S. TOP OF STEEL

T.D.W. TOP OF WALL

TK. THICK

DIMENSIONS INDICATED ARE FINISHED DIMENSIONS. THE CONTRACTOR SHALL MAKE ALLOWANCE FOR FINISH MATERIALS WHEN LAYING OUT THE WORK. FOR PROJECTS INVOLVING ALTERATIONS OR ADDITIONS MANY DIMENSIONS WILL BE BASED ON FIELD MEASUREMENTS OF EXISTING CONSTRUCTION. ON SUCH PROJECTS THE CONTRACTOR WILL BE RESPONSIBLE FOR MAKING MINOR ADJUSTMENTS SO THAT THE NEW WORK FITS PROPERLY TO EXISTING WORK. DIMENSIONS ARE PRE CONSTRUCTION APPROXIMATIONS. THE FINAL DIMENSIONS & S.F. MUST BE DETERMINED FROM ACTUAL MEASUREMENT OF BUILDING AFTER COMPLETION.

MINIMUM

MISCELLANEOUS

MISC.

ABBREVIATIONS

GYP.BD. GYPSUM BOARD

H.V.A.C. HEATING, VENTILATING

HIGH POINT

AIR CONDITIONING

GAL. GALLON

GA. GAUGE

GL. GLASS

HDR HEADER

CONTR. CONTRACTOR

CONV. CONVECTOR

THE CONTRACTOR SHALL PROVIDE ALL LABOR, TOOLS, EQUIPMENT, MATERIALS, AND DEVISES NECESSARY FOR MEANS & METHODS OF CONSTRUCTION AND THE PROPER EXECUTION AND

MATERIALS SHALL BE DELIVERED IN ORIGINAL UNOPENED CONTAINERS. ALL OTHER MATERIALS SHALL BE GRADE MARKED BY THE MANUFACTURER. USED OR SECOND HAND MATERIALS ARE PROHIBITED. THE CONTRACTOR SHALL FOLLOW MANUFACTURER'S INSTALLATION INSTRUCTIONS.

AFTER DEMOLITION AND BEFORE BEGIN ANY WORK THE CONTRACTOR SHALL NOTIFY THE ARCHITECT ABOUT ANY AND ALL DISCREPANCIES BETWEEN FIELD CONDITIONS AND CONTRACT DOCUMENTS BEFORE PROCEEDING WITH AFFECTED PORTION OF WORK, INCLUDES BUT IS NOT LIMITED TO STRUCTURAL AND BEARING ELEMENTS, SHAFTS, MAIN PIPES, ETC. FAILURE TO NOTIFY THE ARCHITECT WILL NOT RELIEVE THE CONTRACTOR OF RESPONSIBILITY TO PERFORM THE WORK AS INDICATED BY THE CONTRACT DOCUMENTS. THE CONTRACTOR SHALL CORRECT ALL WORK ARISING FROM THE FAILURE TO COORDINATE DISCREPANCIES TO THE SATISFACTION OF THE ARCHITECT WITHOUT ADDITIONAL COST.

PROVIDE INTERIOR SHORING, BRACING OR SUPPORT TO PREVENT MOVEMENT SETTLEMENT OR COLLAPSE OF STRUCTURE OR ELEMENT TO BE DEMOLISHED. AND ADJACENT FACILITIES OR PROTECT FROM DAMAGE EXISTING FINISH WORK THAT IS TO REMAIN IN PLACE AND BECOMES EXPOSED DURING DEMOCITION OPERATIONS. 3. PROTECT FLOOR WITH SUITABLE COVERINGS WHERE NECESSARY. 4. CONSTRUCT TEMPORARY INSULATED SOLID DUST PROOF PARTITIONS WHERE REQUIRED TO SEPARATE AREAS WHERE NOISY OR EXTENSIVE DIRT OR DUST OPERATIONS ARE PERFORMED. EQUIP PARTITIONS WITH DUST PROOF DOORS AND SECURITY LOCKS IF REQUIRED. PROMPTLY REPAIR DAMAGES CAUSED TO ADJACENT FACILITIES BY DEMOLITION WORK AT NO OST 10 OWNER.

USE WATER SPRINKLING, TEMPORARY ENCLOSURES AND OTHER SUITABLE METHODS TO LIMIT UST AND DIRT RISING AND SCATTERING IN AIR TO LOWEST PRACTICAL LEVEL. COMPLY WITH OVERNING REGULATIONS PERTAINING TO ENVIRONMENTAL PROTECTION.

INSPECT AREAS IN WHICH WORK WILL BE PERFORMED. PHOTOGRAPH EXISTING EQUIPMENT OR TO SURROUNDING PROPERTIES CONDITIONS TO STRUCTURE SURFACES WHICH COULD BE MISCONSTRUED AS DAMAGE RESULTING FROM DEMOLITION WORK.

8. PROVIDE WEATHER PROOF CLOSURES FOR EXTERIOR OPENINGS RESULTING FROM DEMOLITION

BUILDING DATA

STATE OF NEW JERSEY. ADOPTED CODES AND STANDARDS: - N.J.A.C. REHAB SUBCODE - INTERNATIONAL RESIDENTIAL CODE- NJ ED, 2021-NATIONAL ELECTRICAL CODE, 2020 (NFPA 70). - NATIONAL STANDARD PLUMBING CODE, 2021 - INTERNATIONAL ENERGY CONSERVATION CODE, 2021 (LOW-RISE RESIDENTIAL) - INTERNATIONAL MECHANICAL CODE, 2021. - INTERNATIONAL FUEL GAS CODE, 2021

NUMBER OF STORIES 2 2. BUILDING HEIGHT ±30′-5″ 3. CONSTRUCTION CLASS V-B 4. USE GROUP R-55. NUMBER OF BEDROOMS -

BUILDING AREA/VOLUME CALCULATIONS					
SPACE	AREA (SQ. FT.)	VOLUME (CU. FT.)			
FIRST FLOOR LEVEL	2,067.00	18,603.00			
SECOND FLOOR LEVEL	2,072.00	16,579.00			
BASEMENT FLOOR LEVE	_ 1,807.00	16,263.00			
ATTIC FLOOR LEVEL		8,694.00			
GARAGE	466.00	4,660.00			
TOTAL LIVING AREA:	4,139.00				
TOTAL VOLUME:		64,799.00			

TOTAL ADDITION AREA: 568.00 S.F. TOTAL ADDITION VOLUME: 7'616.00 C.F.

DATE: FOR: 05/30/23 | PERMIT 06/15/23 AS PER ZONING COMMENTS 07/18/23 AS PER CLIENT REQUEST

PROJECT NAME: 65 TROY ROAD **BLOCK 13, LOT 18,** SHORT HILLS TOWNSHIP. ESSEX, NJ, 07078

OWNER:

ISSUANCE:

DANON GROUP

RAFAEL DANON RA. 1218 WARRENS WAY, WANAGUE, NJ,07465 TEL: 201-681-7777 TEL: 973-723-0039 DANONGROUP@AOL.COM

> RAFAEL DANON, R.A., REGISTERED ARCHITECT

COVER SHEET

AS NOTED DRAWN BY: M.A **REVIEWED BY:** R.D.

SHEET TITLE:

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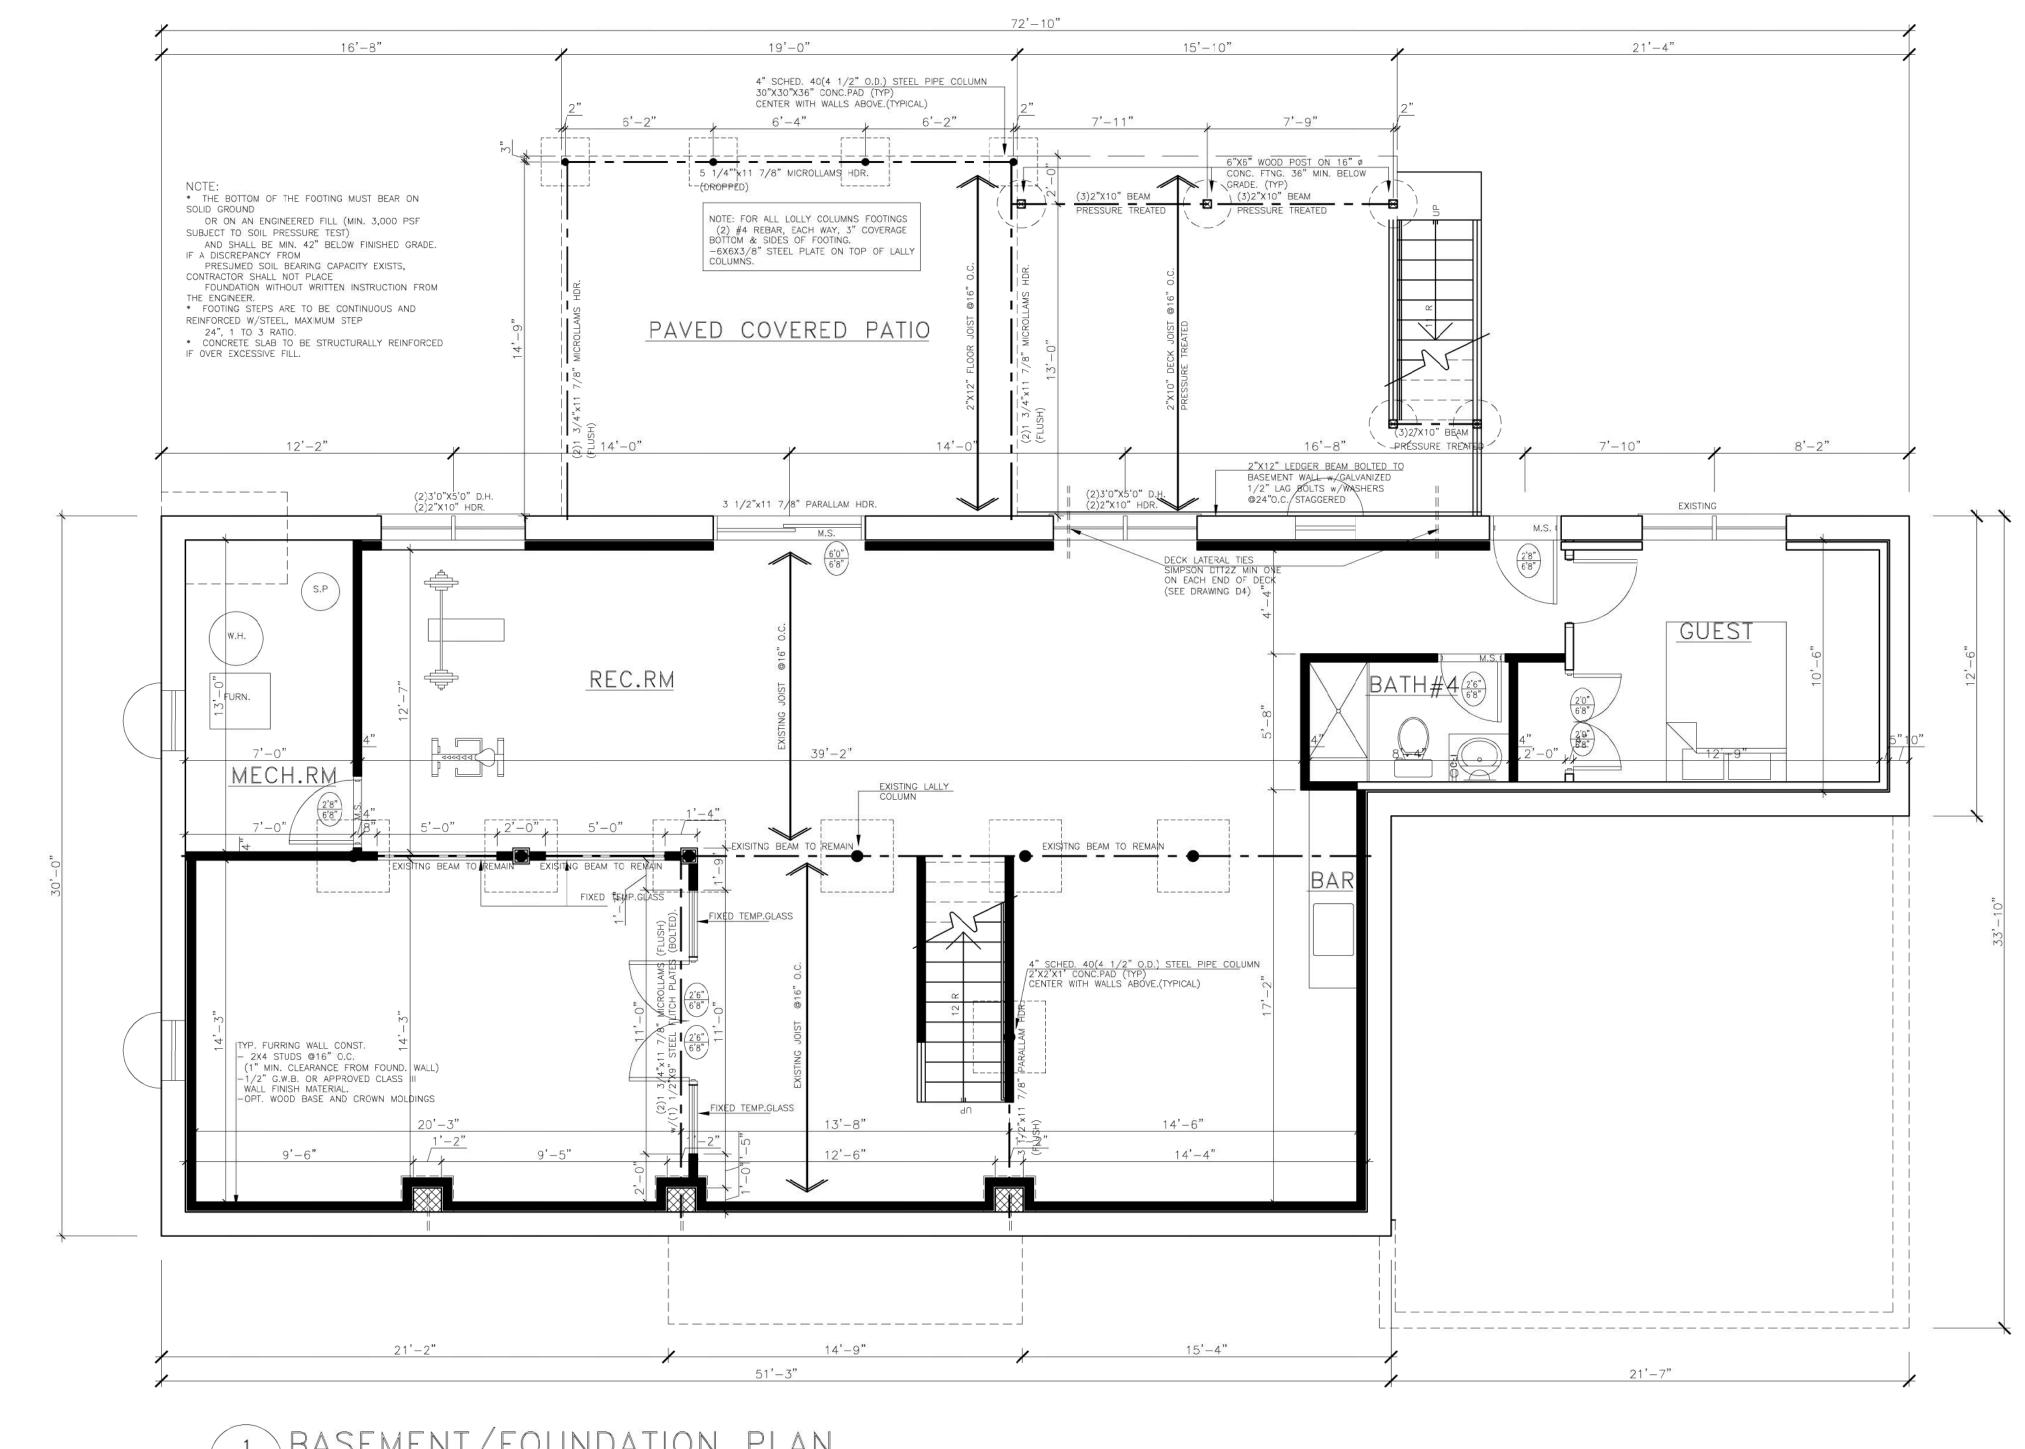
Project Title: 65 troy rd

Report date: 05/29/23

Data filename:

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NOTE: ALL DATA AS PER SURVEY PLAN PREPARED BY LAKELAND SURVEYING 05/17/2023



BASEMENT/FOUNDATION PLAN

SCALE 1/4"=1'-0" AREA - 1807.00 S.F. VOLUME - 16263.00 C.F.

ISS	SUANCE:	
#	DATE:	FOR:
1	05/30/23	PERMIT
2	06/15/23	AS PER ZONING COMMEN
3	07/18/23	AS PER CLIENT REQUEST

PROJECT NAME:

65 TROY ROAD

BLOCK 13, LOT 18,

SHORT HILLS TOWNSHIP,

ESSEX, NJ, 07078

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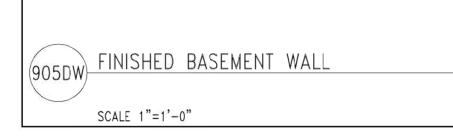
RAFAEL DANON , R.A., REGISTERED ARCHITECT

SHEET TITLE:

FINISHED BASEMENT

SCALE: AS NOTED
DRAWN BY: M.A
REVIEWED BY: R.D.

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FIRST FLOOR

APPROX FIN. GRADE

> EXIST. FOUND. WALL

SEE PLAN CL. 4"

EXIST, FLOOR JOISTS(

NOTE:
FIRESTOP CONCEALED SPACES
OF FURRED WALLS AND
SOFFITS AT 10' INTERVALS
ALONG THE LENGTH OF THE
WALL WITH 5/8" G.W.B.
NAILED TO STUDS AND HELD
TIGHT TO CONC. FOUND. WALL
FROM FLOOR TO CLNG.
FILL REMAINING GAPS AT TOP
AND BOTTOM WITH
INSULATION.
TYP. FURRING WALL CONST.
POLYETYLENE VAPOR BARRIER
-R-13 BATT INSULATION
-2" X 4" WOOD STUDS @16" D.C.
(4" MIN. CLEARANCE FROM FOUND. WALL)
-1/2" G.W.B. OR APPROVED CLASS III
WALL FINISH MATERIAL.
-OPT. WOOD BASE AND CROWN MOLDINGS

2"X24" RIGID R-8
STYRDFDAM
INSULATION HORIZ. &
VERT. 2' AROUND THE
PERIMETER (TYP)

FRAMING NOTES

1. ALL LUMBER, WOOD CONSTRUCTION AND FASTENING TO CONFORM TO SPECIFICATION AND CODES MODIFICATIONS SET FORTH IN SECTION 6.1 OF THE GENERAL NOTES (SEE SHEET G-1).

2. ALL LUMBER SHALL BE AIR KILN DRIED (MC=15% MAX.) AND SHALL BE FREE FROM LOOSE LARGE KNOTS, EXCESS SAP OR OTHER DEFECTS WHEREBY IT'S STRENGTH MAY BE IMPAIRED.

3. SET ALL JOISTS AND BEAMS WITH NATURAL CAMBER UP. ENDS LAPPED MIN. 6" OVER BEARING SHALL BE SECURELY SPIKED TOGETHER. PROVIDE AT LEAST 1-1/2" BEARING ON ALL JOISTS.

4. EXTERIOR WALL FRAMING SHALL BE MIN. 2"x6"@16" O.C. w/DOUBLE TOP PLATES U.O.N.

5. EXTERIOR SHEATHING SHALL BE 1/2" EXTERIOR GRADE PLYWOOD SHEATHING IN 4'x8', 9' OR 10' PANELS.

6. PARTITIONS SHALL BE FRAMED WITH MIN. 2"x4"@16" O.C. HEM—FIR STUD GRADE OR BETTER.

7. PROVIDE METAL OR 5/4"x3" WOOD CROSS BRIDGING AT A MAX. OF 8'—0" O.C. AND SOLID BRIDGING AT JOIST ENDS.

8. DOUBLE FLOOR JOISTS UNDER ALL INTERIOR PARTITIONS RUNNING PARALLEL TO FRAMING.

9. PROVIDE SOLID BLOCKING UNDER ALL POINT LOADS AND COLUMNS.

10. INSTALL 1/2" CDX PLYWOOD ROOF SHEATHING (3/4" WITH 24" O.C. FRAMING), SHEATHING TO BE FIRE—RETARDANT TREATED AT 4'—0" ON EITHER SIDE OF RATED WALL

ASSEMBLIES ABUTTING ROOFING.

11. UNDER FLOORING SHALL BE MIN. 1 LAYER 3/4" T&G C.D. PLYWOOD OR AS NOTED ON PLANS. GLUE ALL EDGES SUPPORTED. ALLOW MIN. 1/16" BETWEEN JOINTS AND 1/8" AT EDGES FOR EXPANSION.

12. ALL HEADERS FOR OPENINGS IN FRAME WALLS TO BE MIN. (2)2"x8" U.O.N. (SEE HEADER TABLE ON SHEET G-1) USE

3/8" PLY PACK-OUT TO MATCH STUD THICKNESS. MIN.

BÉARING TO BE 3" U.O.N.

13. ALL FRAMING EXPOSED TO MASONRY OR WEATHER TO BE PRESSURE TREATED.

14. FIRE—STOP ON WALLS 10' OR HIGHER WALLS AT MID—HEIGHT. FIRE STOP ALL VERTICAL/HORIZONTAL

MID—HEIGHT. FIRE STOP ALL VERTICAL/HORIZONTAL CONNECTIONS SUCH AS DROPPED SOFFITS AND DROPPED CEILINGS, AT OPENINGS ABOVE DUCTS, CHIMNEYS, VENTS AND PIPES.

15. DRAFT STOP NON—SPRINKLERED RESIDENTIAL HUNG

CEILING SPACES AT 500 S.F. MAX. AND 3,000 S.F. OF ATTIC. DRAFT STOP R-1 AND R-2 ABOVE TENANT SEPARATION WALLS.

16. HIP AND VALLEY BEAMS AND RIDGES TO BE 2"x MEMBERS OF ONE SIZE LARGER THAN RAFTERS. DOUBLE UP HIP AND VALLEY RAFTERS.

17. ALL REPETITIVE MEMBER FRAMING SHALL BE 16" O.C. U.O.N.

18. PROVIDE MIN. 2"x4" COLLAR TIES @ 16" O.C. AT UPPER 1/3 OF VERTICAL DISTANCE BETWEEN RIDGE BOARD AND

20. ADEQUATE CONNECTIONS IS THE SOLE RESPONSIBILITY OF THE GENERAL CONTRACTOR AND HIS SUBS.

21. INSTALL PRESSURE TREATED LUMBER WHERE LUMBER IS IN CONTACT WITH CONCRETE, SILLS AND PLATES LESS THAN 8" FROM THE GROUND, AND ALL WOOD SIDING, SHEATHING AND WALL FRAMING ON THE EXTERIOR OF A BUILDING LESS THAN 6" FROM THE GROUND.

SMOKE DETECTOR NOTES

THE INSTALLATION OR WIRING AND EQUIPMENT SHALL BE IN ACCORDANCE WITH THE APPLICABLE ELECTRICAL CODE.
 SMOKE DETECTORS SHALL BE PROVIDED AS FOLLOWS:

. SMOKE DETECTORS SHALL BE PROVIDED AS FOLLOWS:

a. ON EACH AND EVERY FLOOR LEVEL AND WITHIN
PROXIMITY OF EACH SEPARATE SLEEPING AREA AND;

b. WITHIN EACH AND EVERY SLEEPING ROOM IN THE
DWELLING UNITS INCLUDING ANY ENCLOSED ROOM
WITH CLOSET OR EGRESS WINDOW AND;

c. IN BASEMENT AND RECREATION ROOMS.

EACH SMOKE DETECTOR SHALL HAVE AN INTEGRAL TEST

MEANS TO PERMIT THE OCCUPANT TO CHECK THAT IT IS
OPERATIONAL. A CONTINUOUS POWER DISPLAY INDICATOR LIGHT IS
RECOMMENDED.

4 SMOKE DETECTORS SHALL BE LOCATED ON OR NEAR THE

4. SMOKE DETECTIONS SHALL BE LOCATED ON OR NEAR THE CEILING AND WITHIN 15 FEET OF ALL ROOMS USED FOR SLEEPING PURPOSES.

5. IF CEILING MOUNTED THE CLOSEST EDGE OF DETECTORS SHALL BE MIN. OF 4" FROM ANY WALL.


6. IF WALL MOUNTED, THE CLOSEST EDGE OF THE DETECTORS SHALL BE MIN. OF 4" AND MAX. OF 12" FROM THE CEILING.

7. ALL SMOKE DETECTORS SHALL BE A/C INTERCONNECTED AND SHALL BE PROVIDED WITH A BATTERY BACKUP SYSTEM IN CASE OF POWER INTERUPTION.

8. UNITS TO BE EITHER IONIZATION CHAMBER OR PHOTOELECTRIC TYPE AND COMPLY WITH RS 17–11. UNITS TO BE APPROVED BY BOARD OF STANDARDS AND APPEALS OR BE LISTED BY AN ACCEPTED TESTING LABORATORY SUCH AS

DETECTORS—ANSI/INFIPA NO. 74.

9. A CERTIFICATE OF SATISFACTORY INSTALLATION MUST BE FILED WITH THE DIVISION OF CODE ENFORCEMENT TEN DAYS AFTER THE INSTALLATION OF SMOKE DETECTORS.

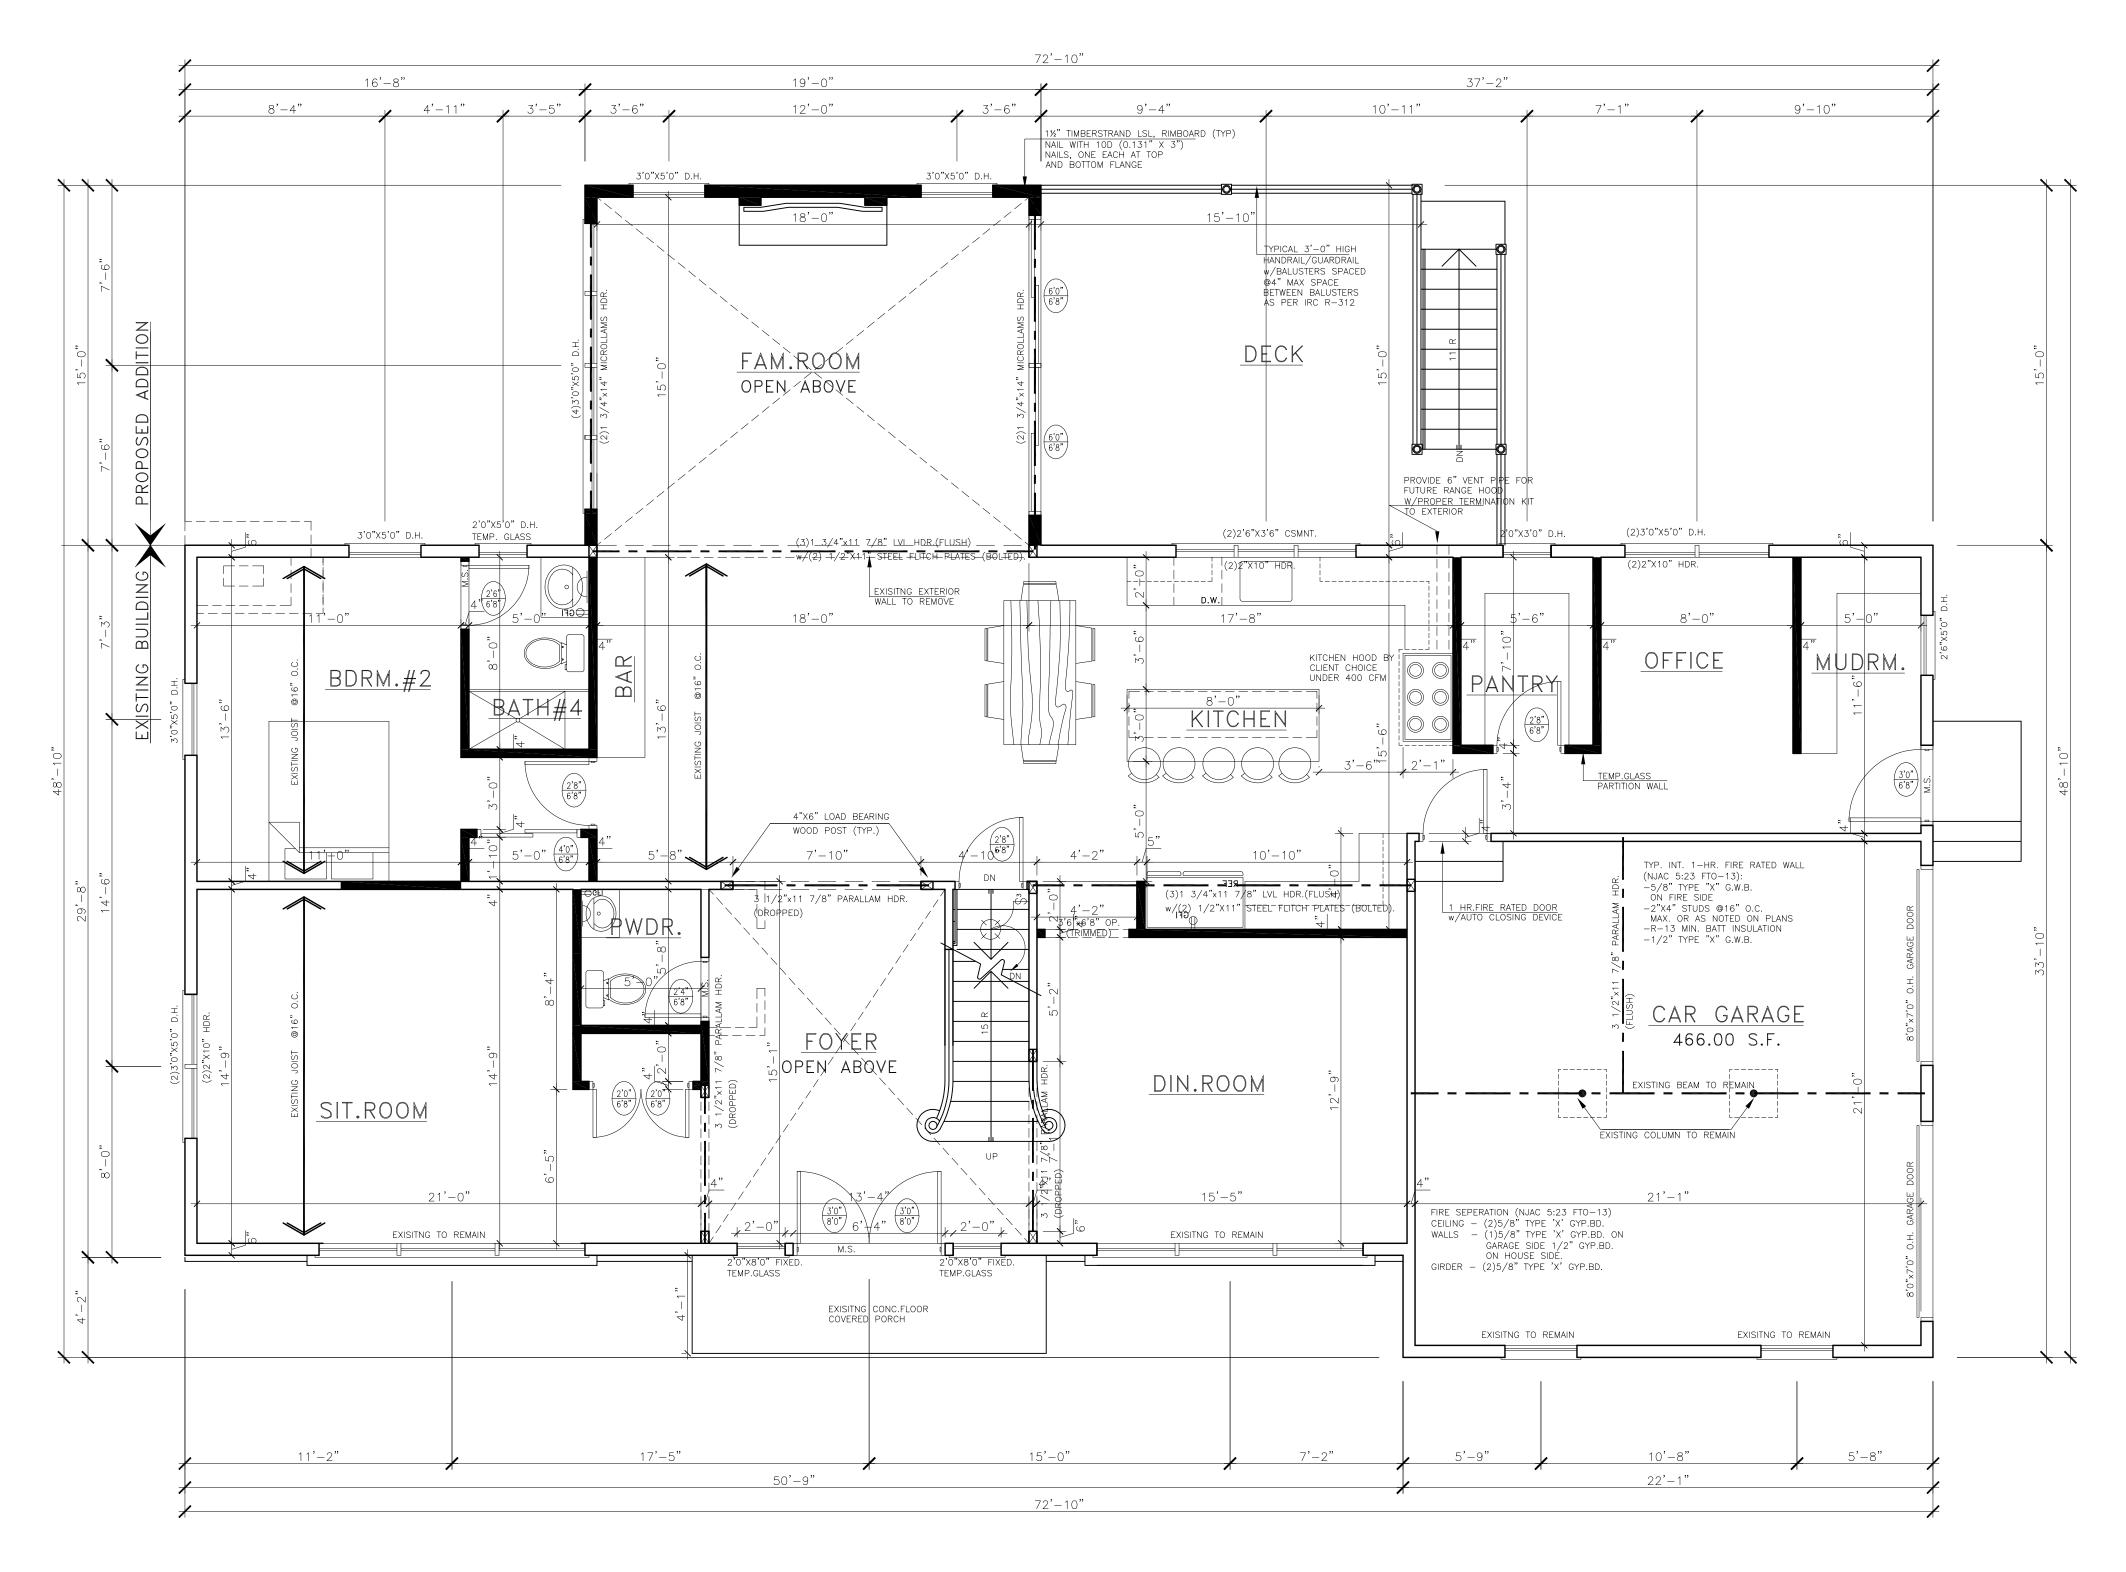

1 FIRST FLOOR PLAN

SCALE 1/4"=1'-0" AREA - 2067.00 S.F. VOLUME - 18603.00 C.F.

FLOOR PLAN NOTES:

- CONSTRUCTION:

 A. ALL PARTITIONS ARE 3½" ROUGH (U.O.N.)

 B. ALL ANGLED PARTITIONS ARE 45 DEGREES (U.O.N.)
- B. ALL ANGLED PARTITIONS ARE 45 DEGREES (U.O.N.)
 C. ALL WINDOWS HEAD HEIGHTS TO BE AT 6'-8" OFF
 FINISHED FLOOR ELEVATION (U.O.N.)
 D. ALL EXTERIOR 2"X6" WALLS ARE TO HAVE R-19

FOUNDATION VIA BEAMS, POSTS AND/OR SOLID WOOD

- INSULATION.
 E. (3)2"X4" (MIN.) POST AT EACH END OF ALL BEAMS
 AND GIRDER TRUSSES (U.O.N.) ALL SUCH
 CONCENTRATED LOADS SHALL BE TRANSFERRED TO
- BLOCKING.

 F. ALL DIMENSIONS ARE TO FACE OF STUD (U.O.N.)

H. DOUBLE FLOOR JOISTS UNDER ALL BEARING WALLS RUNNING PARALLEL TO FRAMING, UNLESS OTHERWISE NOTED ON PLANS.

2. CEILING HEIGHTS IRC 305.1: HABITABLE ROOMS, HALLWAYS, CORRIDORS, BATHROOMS, TOILET ROOMS, LAUNDRY ROOMS AND HABITABLE BASEMENTS SHALL HAVE A CEILING

HEIGHT OF NOT LESS THAN 7'-0" MEASURED TO THE LOWEST PROJECTION FROM THE CEILING.

3. ATTIC ACCESS IRC 1305.1.3:

3. ATTIC ACCESS IRC 1305.1.3:

A. AN ATTIC ACCESS SHALL BE PROVIDED WHERE INDICATED. UNLESS OTHERWISE NOTED OR REQUIRED, THE OPENING SHALL NOT BE LESS THAN 20"X30".

B. ALL ATTIC ACCESS OPENINGS, OR OTHER OPENINGS INSTALLED IN TOP CEILINGS, SHALL BE CLOSED, GASKETED OR OTHERWISE SEALED WITH MATERIALS

4.THE ACTUAL SIZE MAY DIFFER ACCORDING TO MANUFACTURER. THE SHOWER COMPARTMENT IS TO BE TILED TO A HEIGHT OF 6'-6". TILED FLOORS, BATH TUBS INDICATED ARE OF STANDARD SIZE. THE ACTUAL SIZE MAY DIFFER ACCORDING TO MANUFACTURE. WHERE A SHOWER HEAD IS PROVIDED, THE COMPARTMENT SHALL BE TILED TO A HEIGHT OF 6'-6". FIBERGLASS UNITS ARE OPTIONAL AND MAY BE

5. BATH IN ATTIC SPACE: ATTIC SIDE OF BATH WALLS SHALL BE SHEATHED. DRAFT STOP FLOOR JOISTS UNDER BATH WALLS.

- 7. PROVIDE MOISTURE RESISTANT G.W.B. AROUND ALL WET AREAS IN KITCHENS AND BATHROOMS.
- 8. ALL WINDOWS DESIGNATIONS ARE GENERIC SIZES.

LAUNDRY ROOM NOTES:

LAUNDRY ROOM: ALL LAUNDRY ROOMS SHALL BE PROVIDED WITH A LOUVERED DOOR. WHERE GAS DRYER IS USED OR THE LAUNDRY ROOM SHALL BE PROVIDED WITH (2) OPENINGS ONE

LAUNDRY ROOM SHALL BE PROVIDED WITH (2) OPENINGS ONE WITHIN 12 INCHES OF THE BOTTOM OF THE SPACE, AND ONE WITHIN 12 INCHES OF THE TOP OF THE SPACE.

ISS	SUANCE:	
#	DATE:	FOR:
1	05/30/23	PERMIT
2	06/15/23	AS PER ZONING COMMEN
3	07/18/23	AS PER CLIENT REQUEST

PROJECT NAME:

65 TROY ROAD BLOCK 13, LOT 18, SHORT HILLS TOWNSHIP, ESSEX, NJ, 07078

OWNER:

DANON GROUP

RAFAEL DANON RA.
1218 WARRENS WAY,
WANAGUE, NJ,07465
TEL: 201-681-7777
TEL: 973-723-0039
DANONGROUP@AOL.COM


RAFAEL DANON , R.A., REGISTERED ARCHITECT

SHEET TITLE:


FIRST FLOOR PLAN PROPOSED


SCALE: AS NOTED DRAWN BY: M.A REVIEWED BY: R.D.


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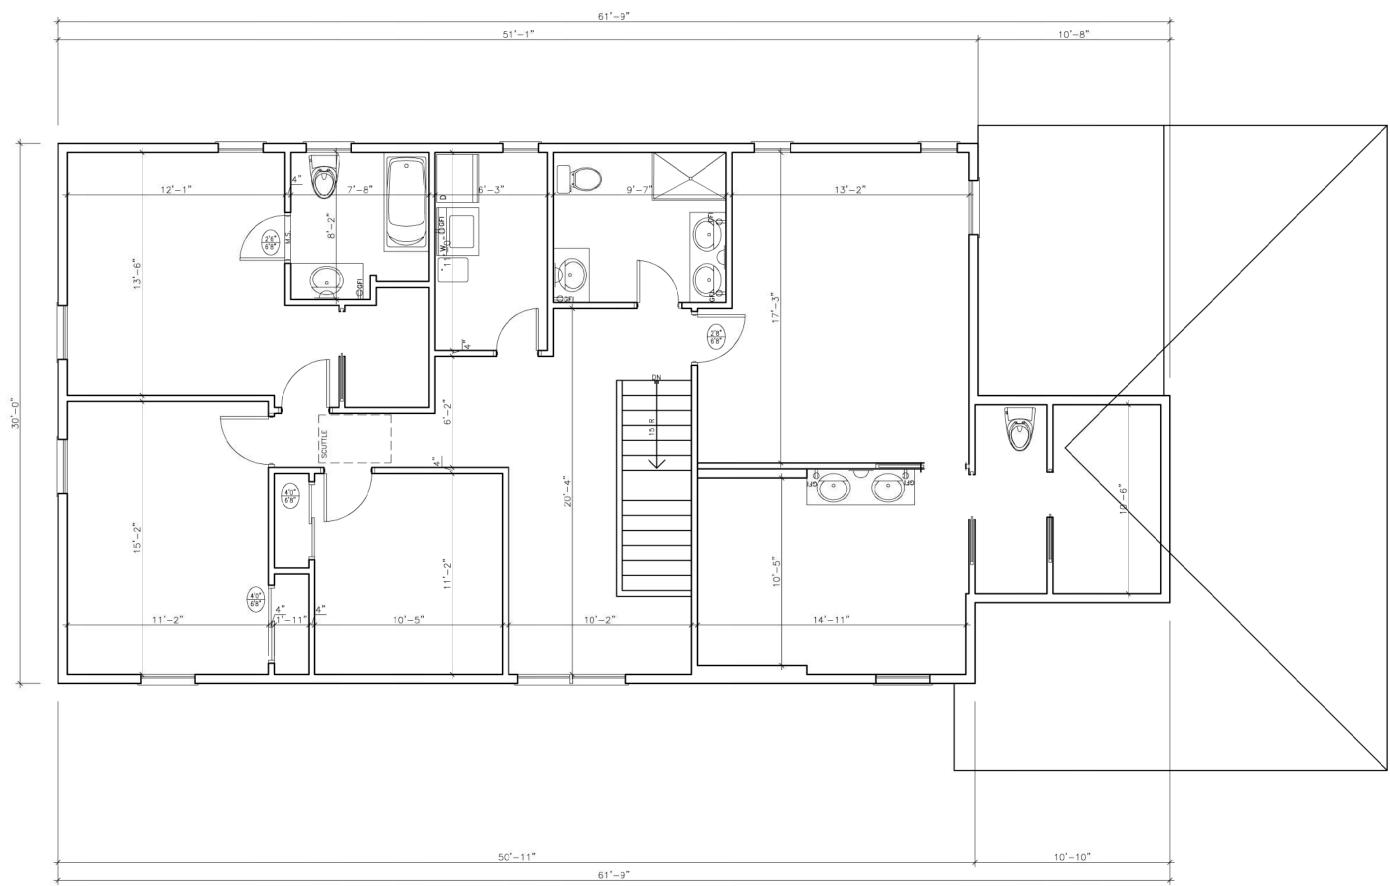


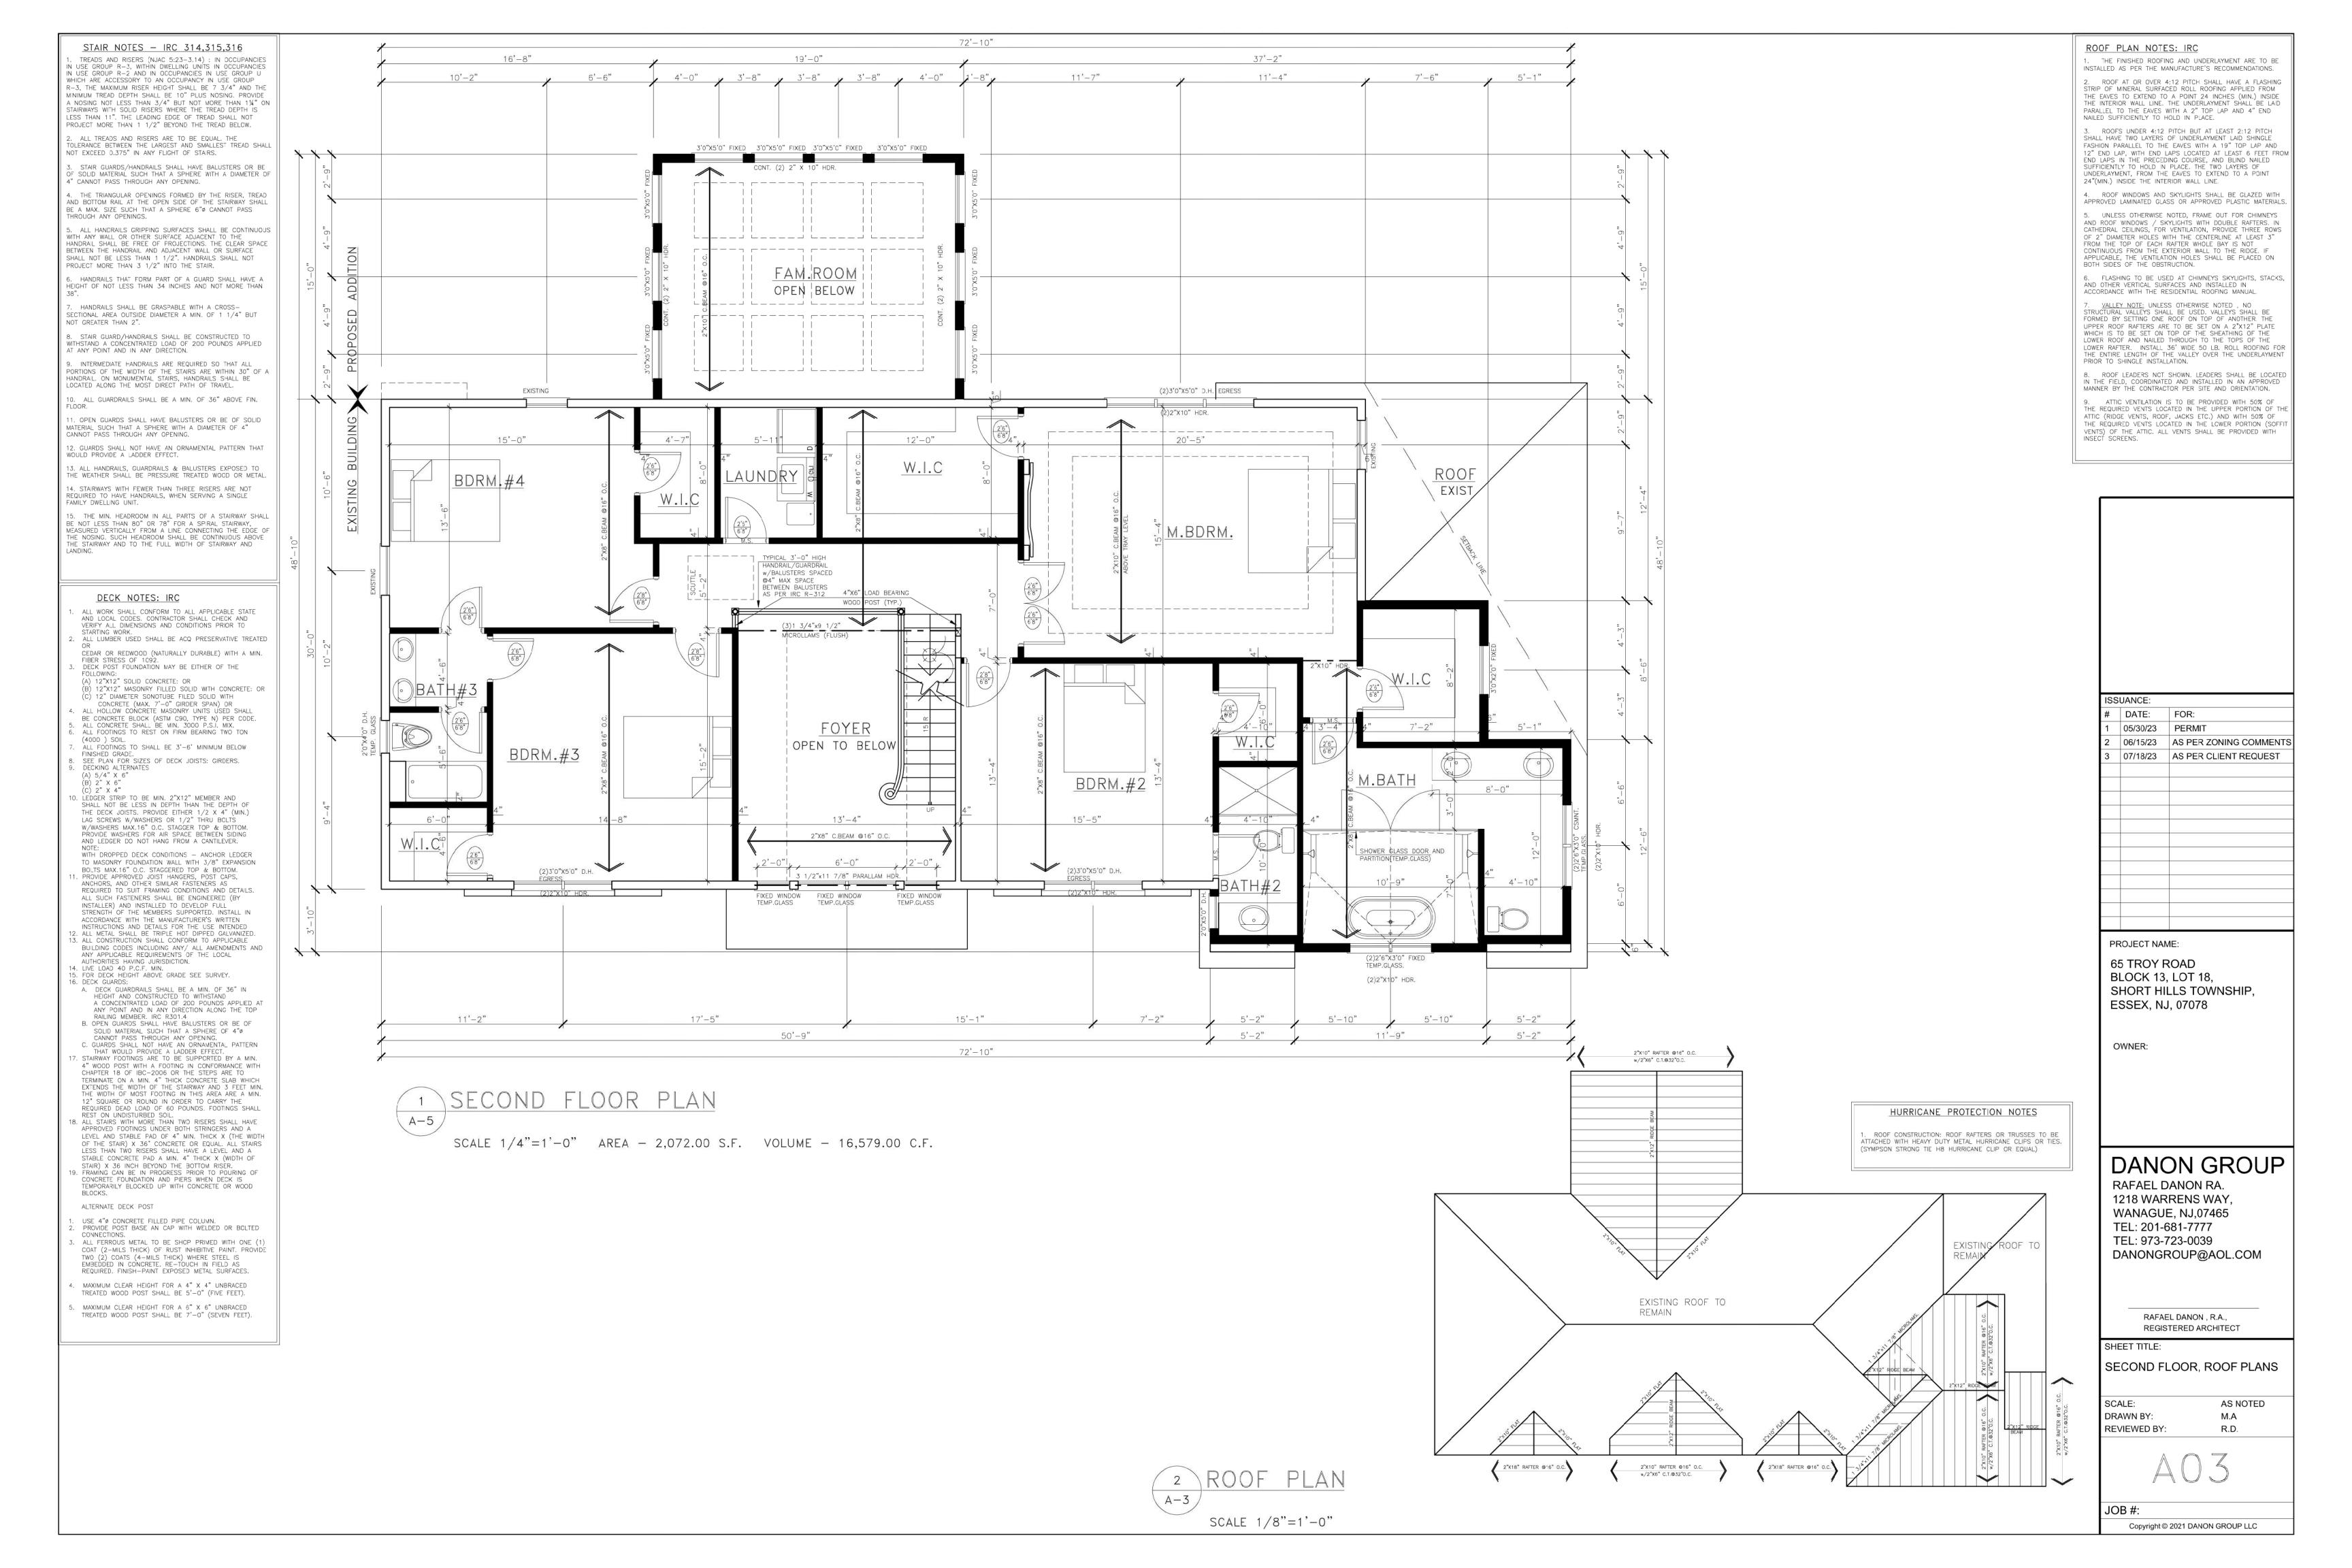

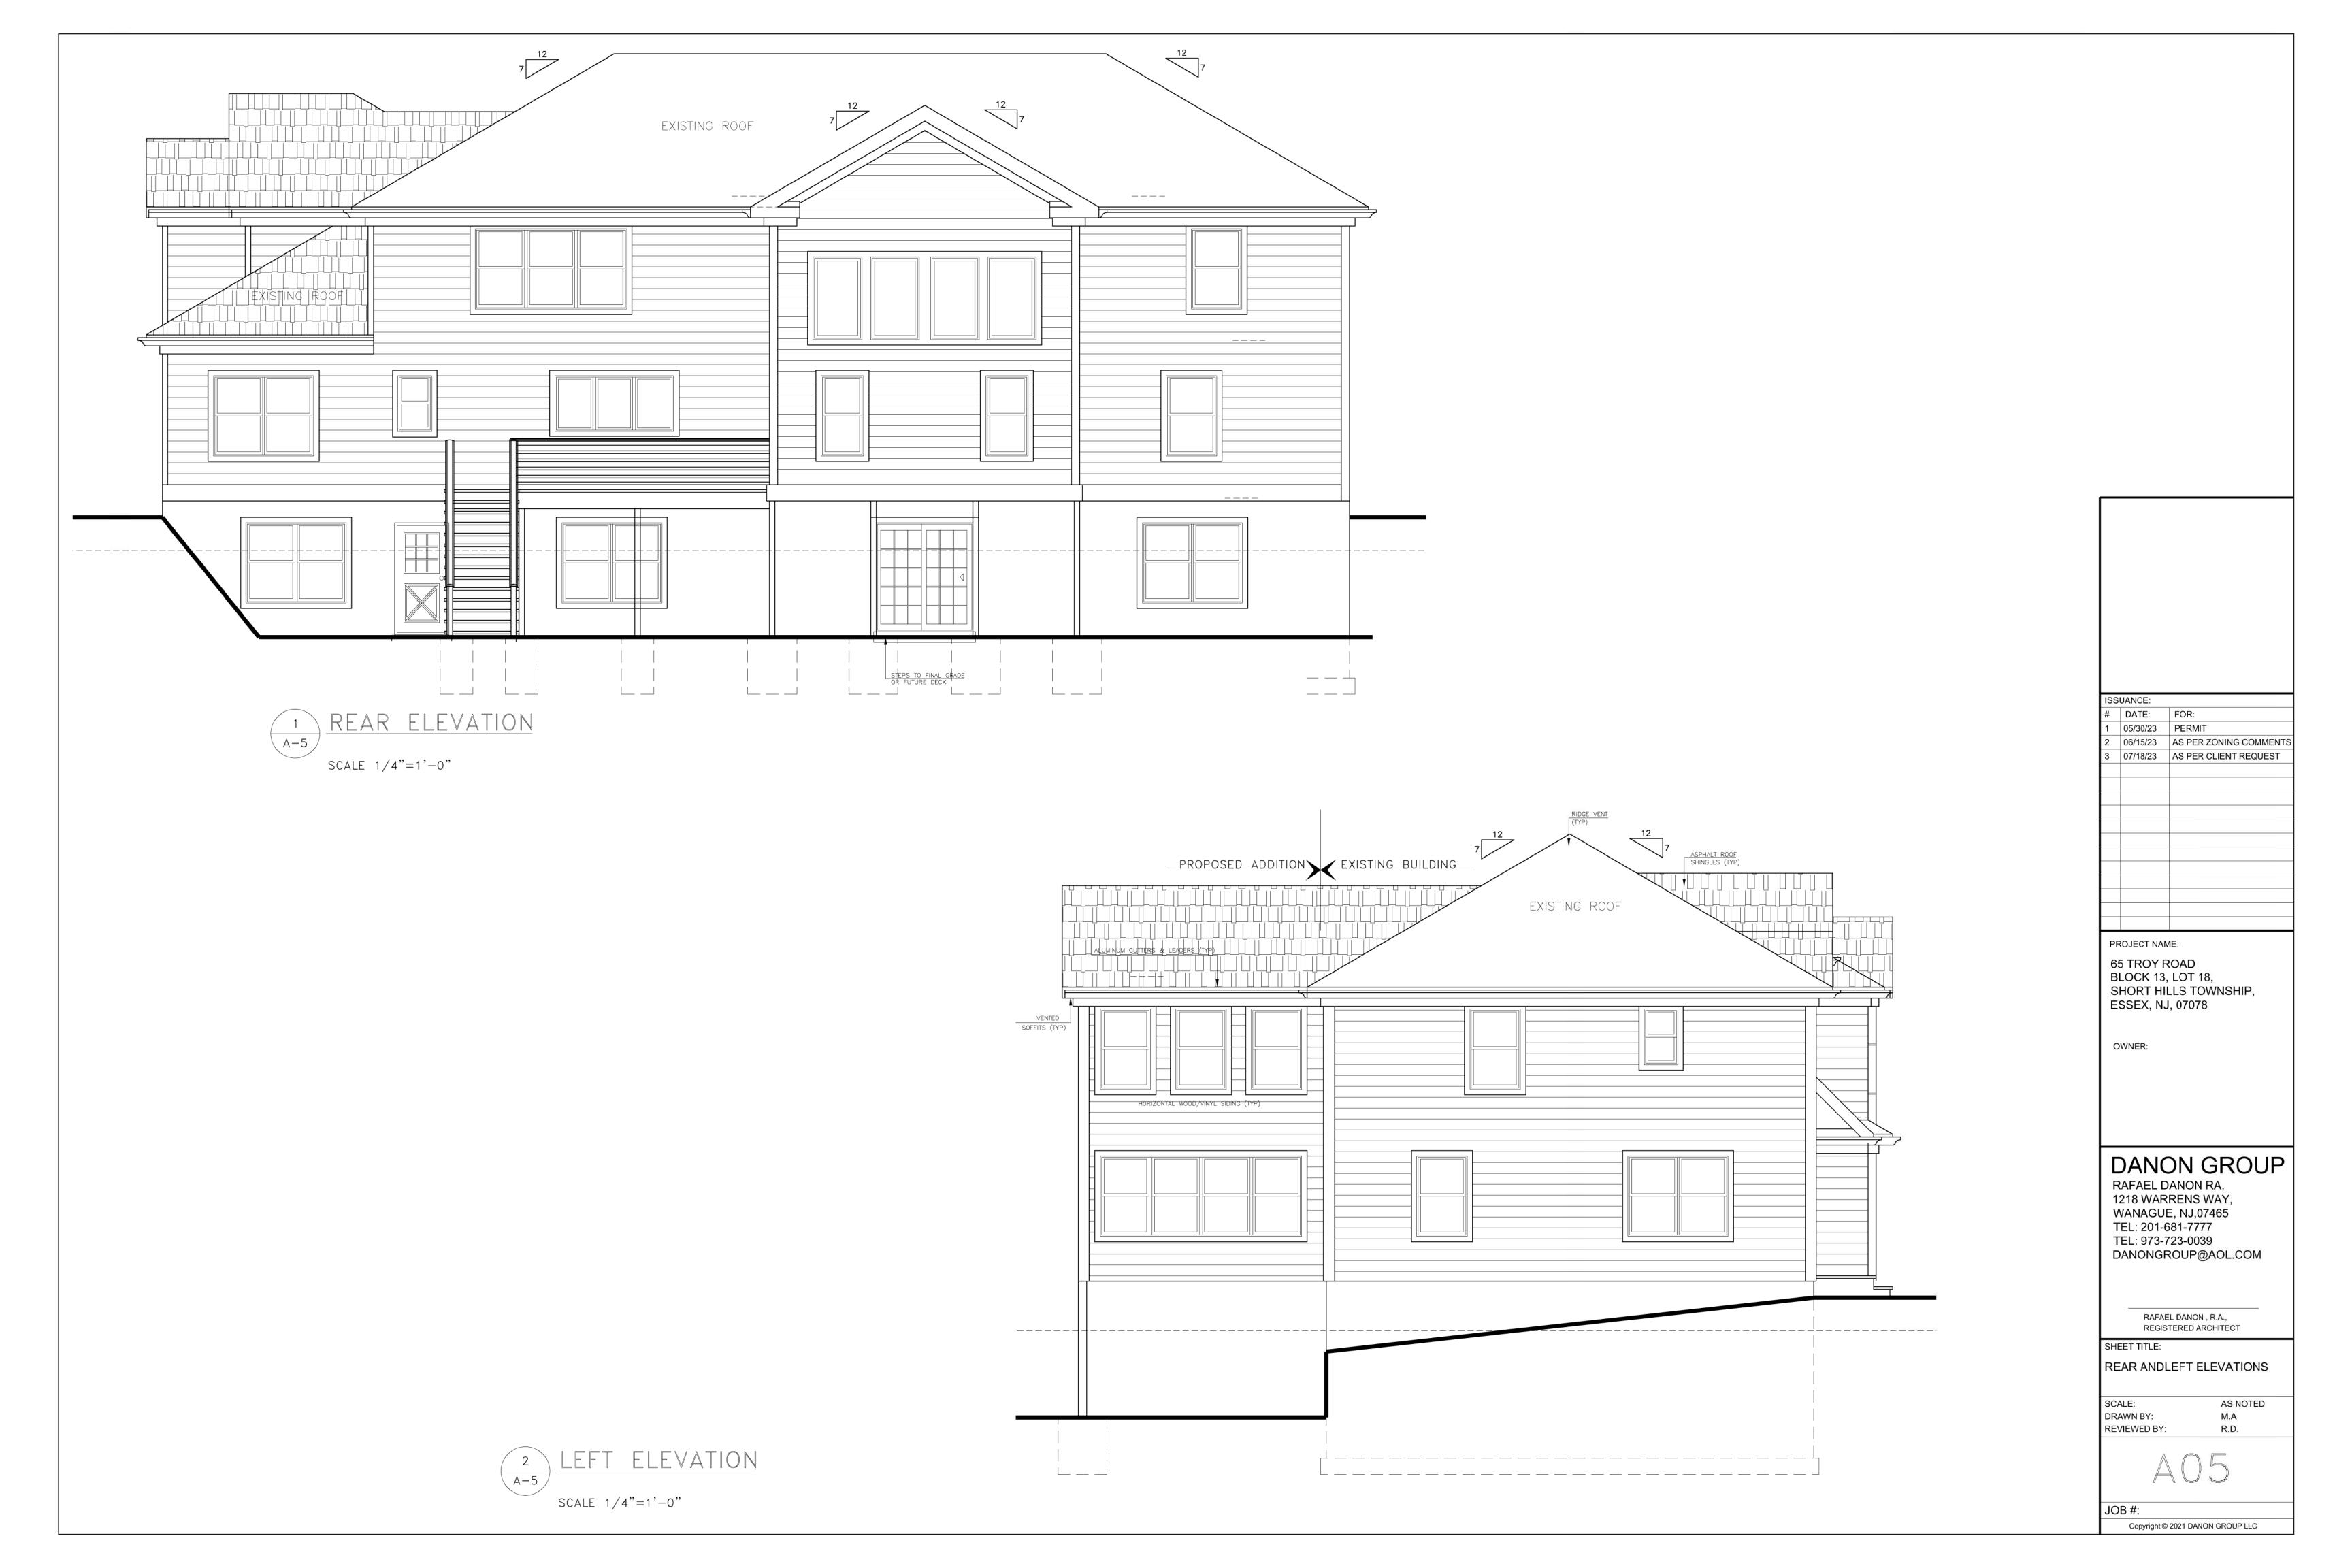


SCALE 1/4"=1'-0" AREA - 1785.00 S.F. VOLUME - 16065.00 C.F.

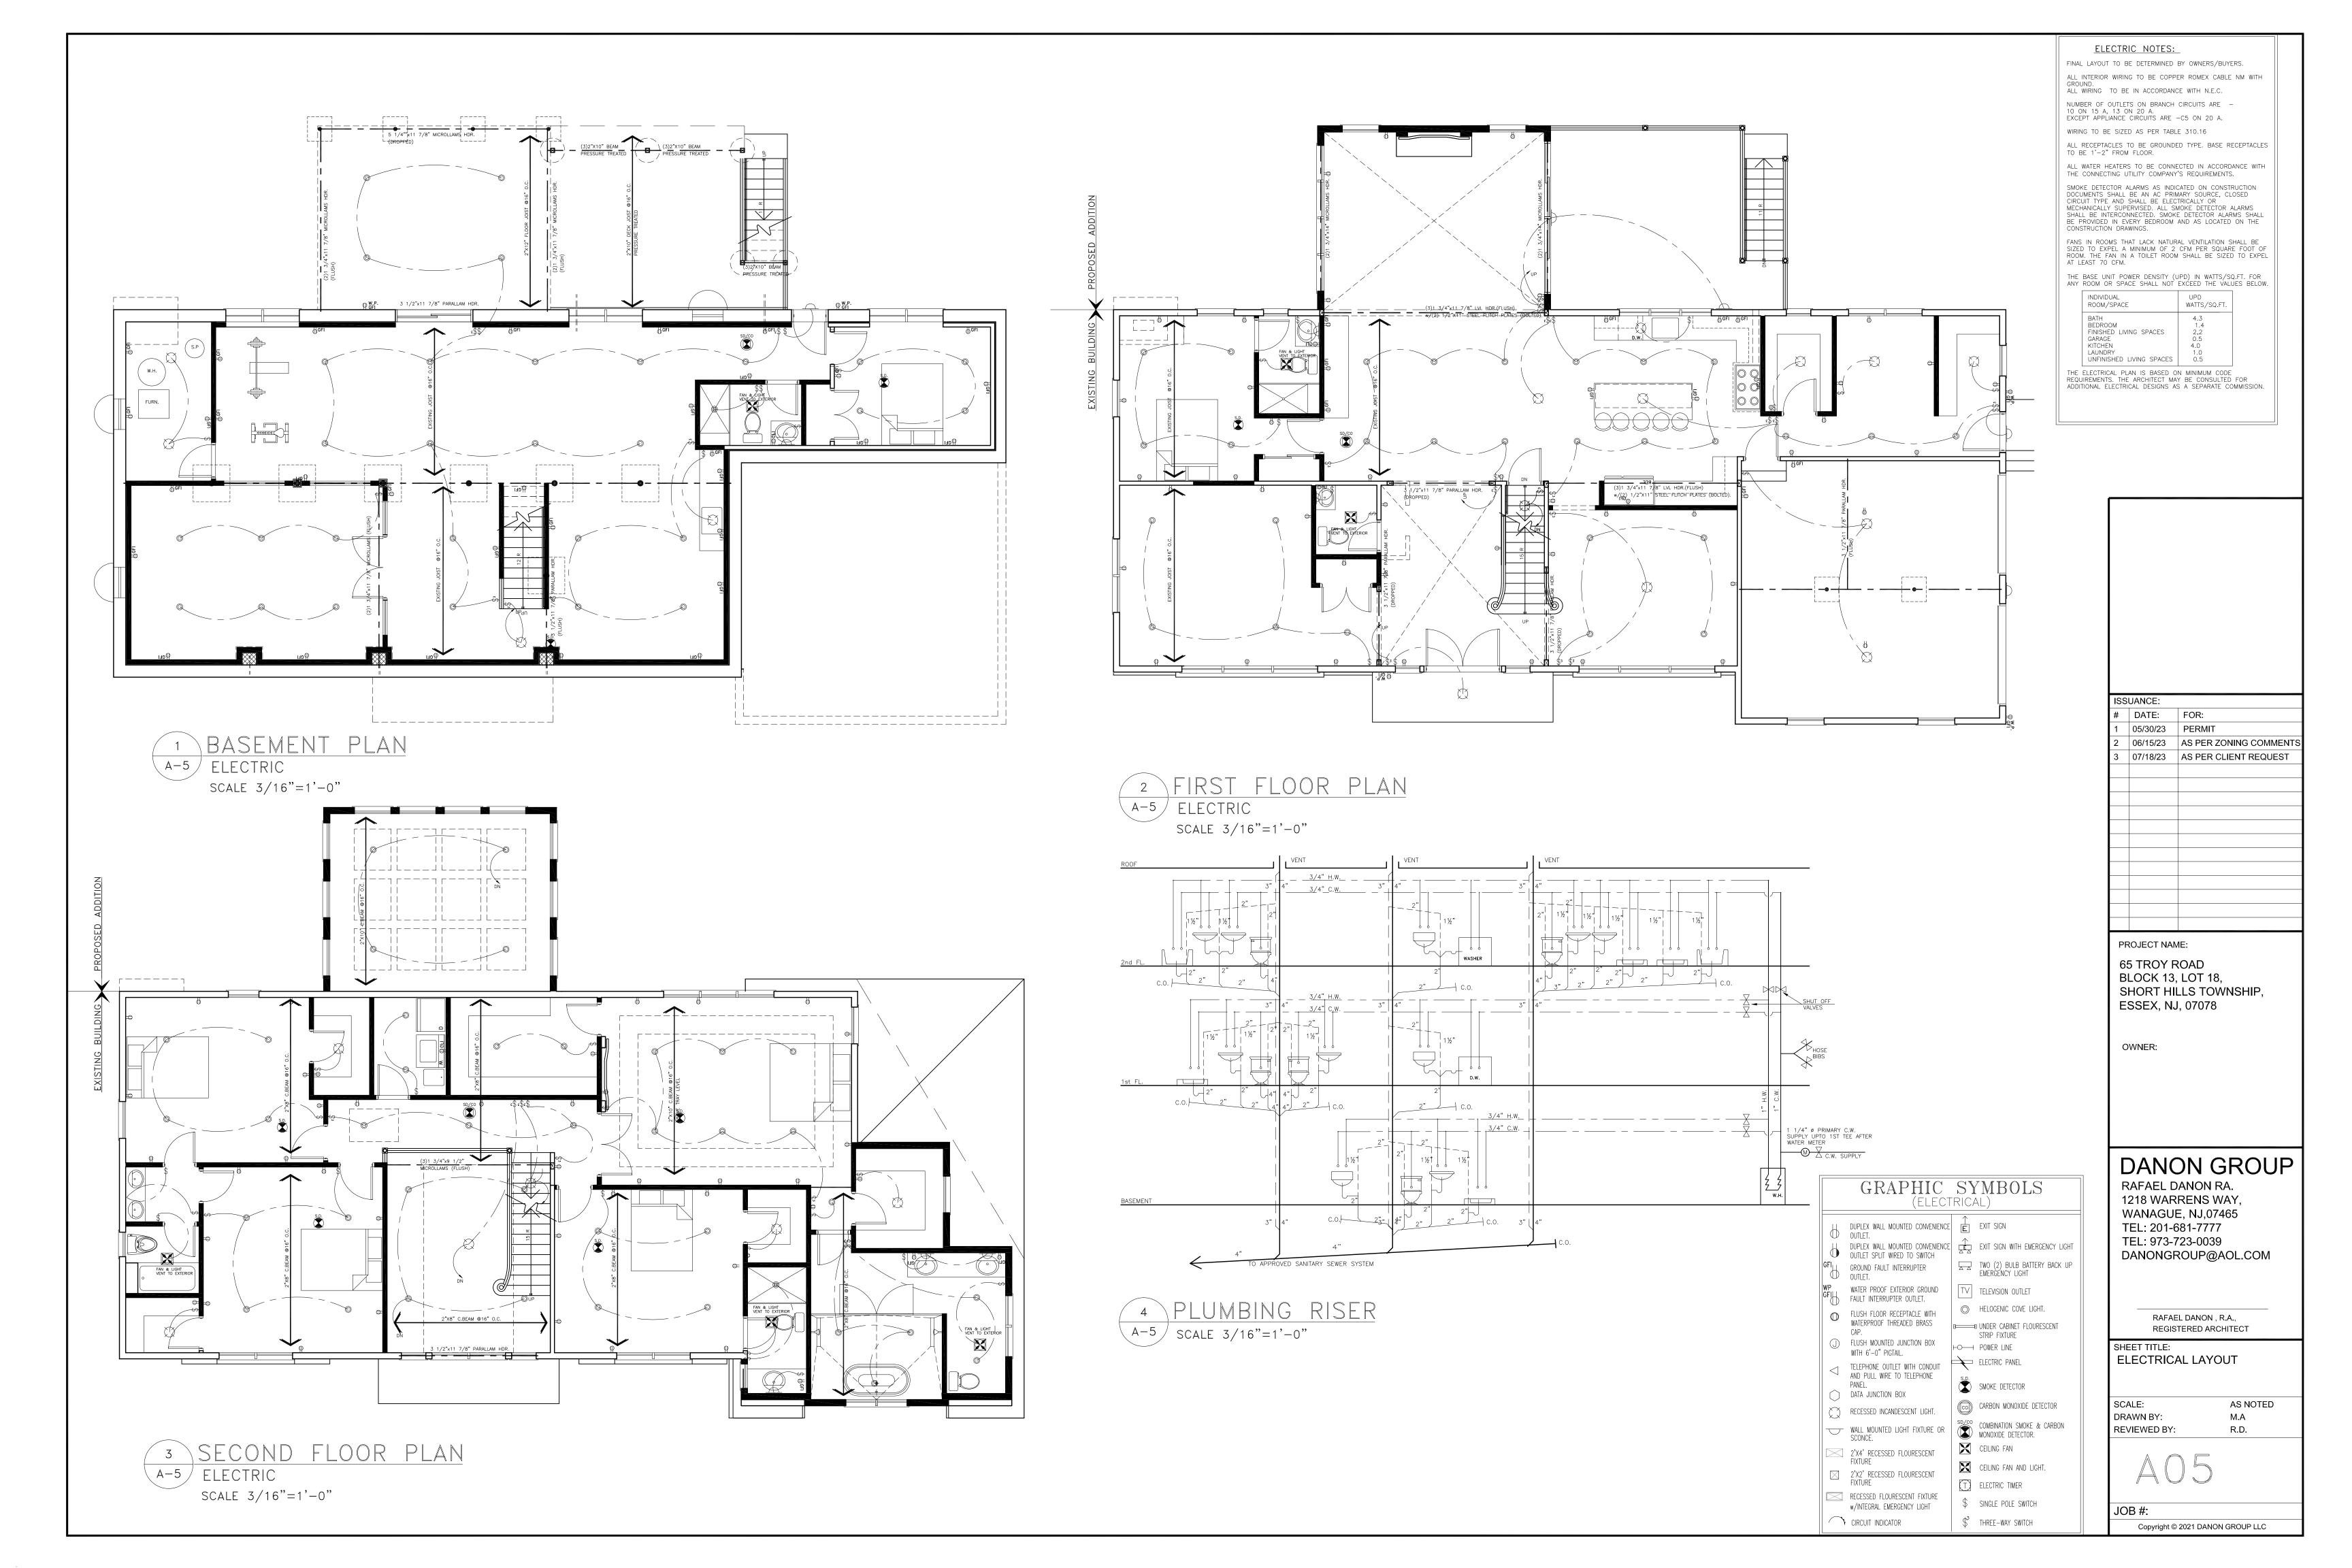SCALE 1/4"-1'-0" ADEA - 1654 00 SE VOLLIME - 14256 00 CE

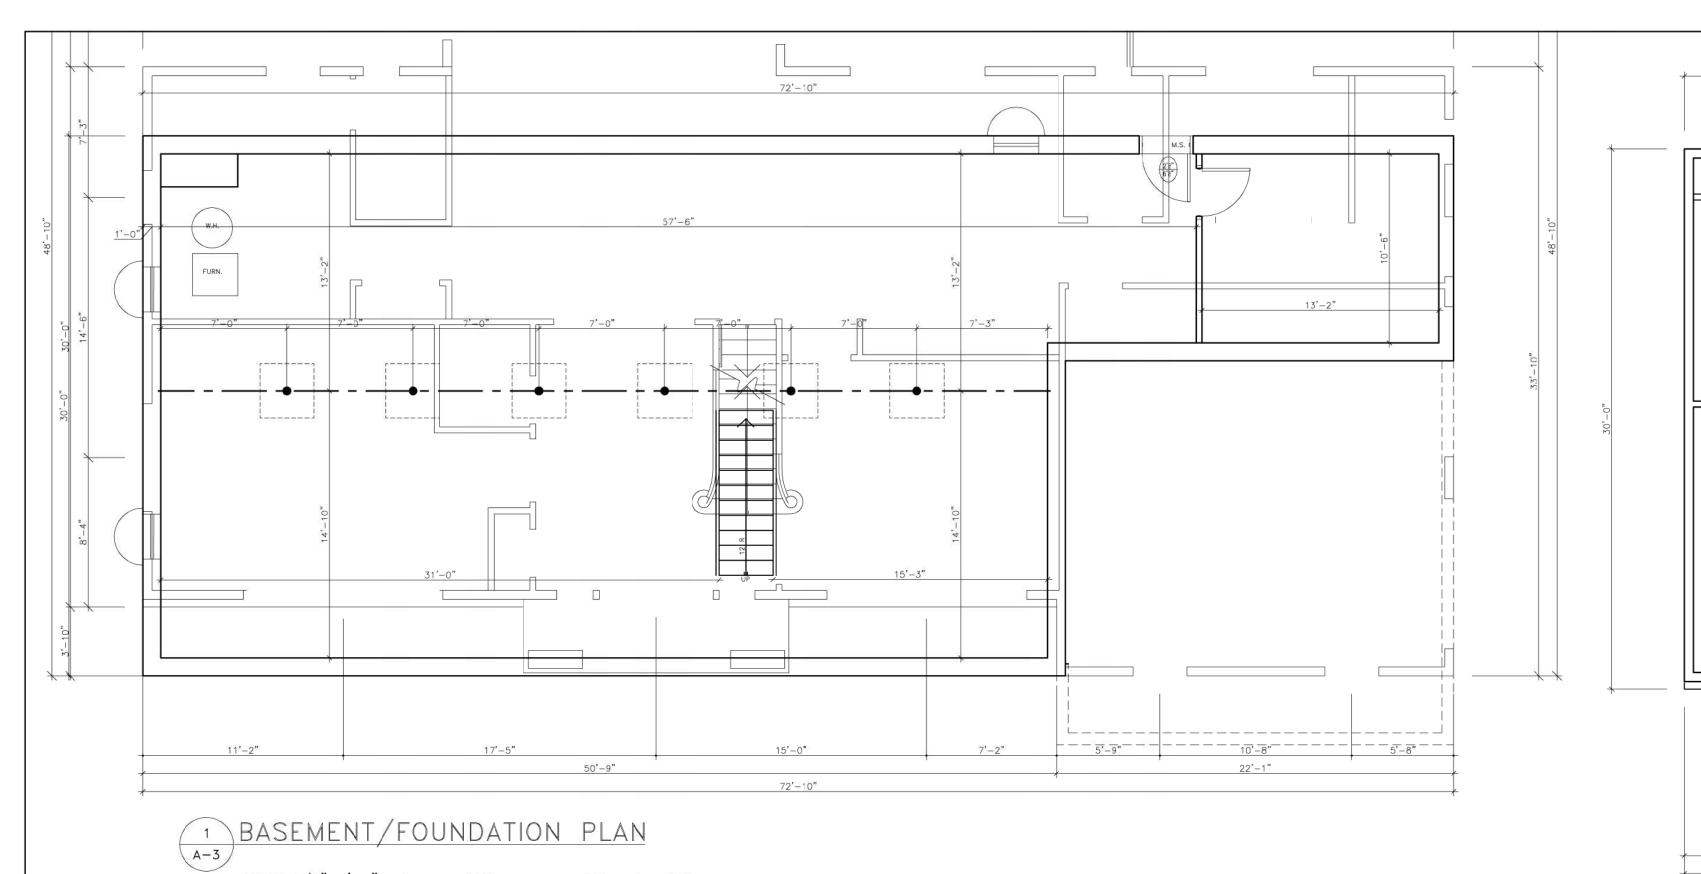

SECOND FLOOR PLAN

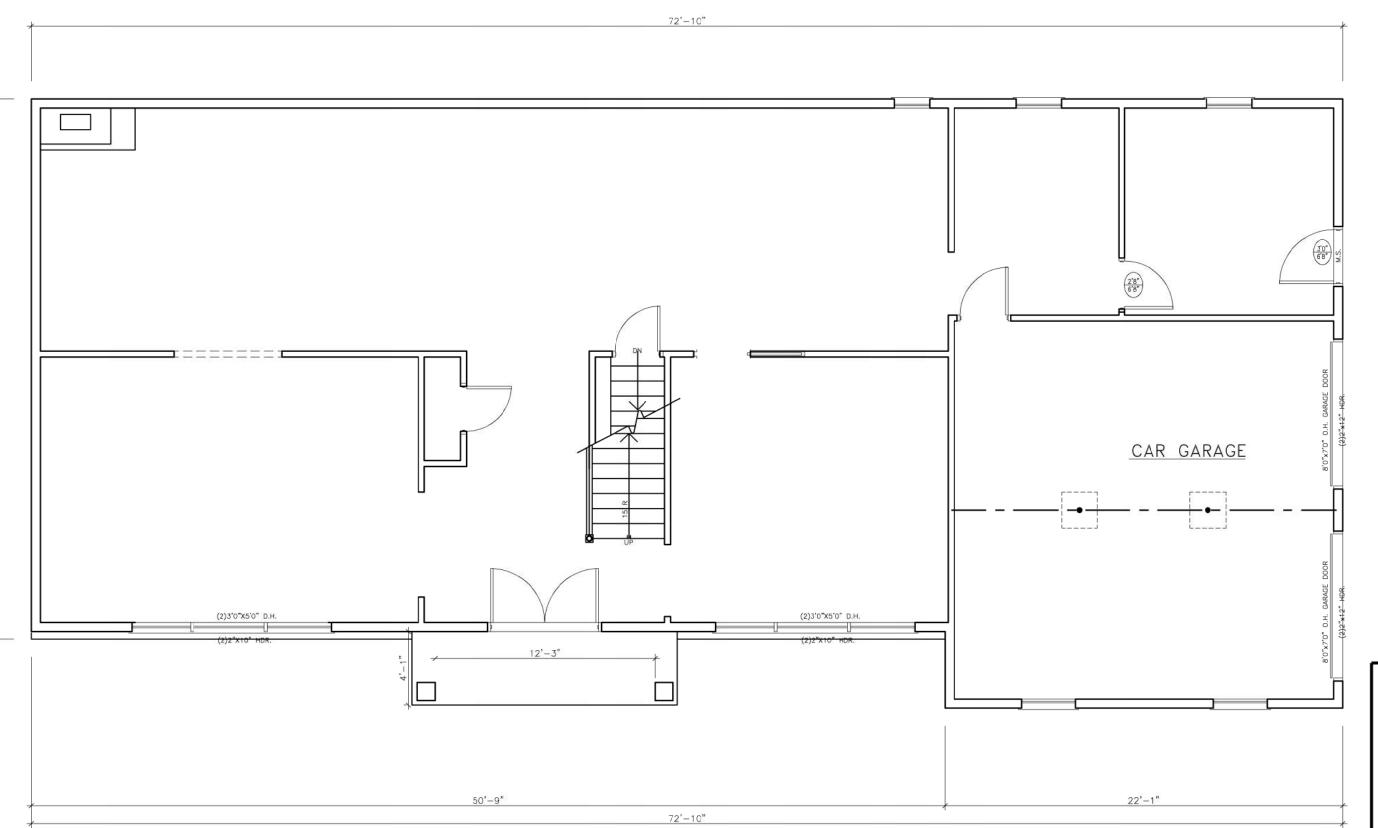

FIRST FLOOR PLAN

SCALE 1/4"=1'-0" AREA - 1782.00 S.F. VOLUME - 16038.00 C.F.

153	SUANCE:	
#	DATE:	FOR:
1	05/30/23	PERMIT
2	06/15/23	AS PER ZONING COMMENTS
3	07/18/23	AS PER CLIENT REQUEST

PROJECT NAME: 65 TROY ROAD BLOCK 13, LOT 18, SHORT HILLS TOWNSHIP, ESSEX, NJ, 07078

OWNER:

DANON GROUP

RAFAEL DANON RA. 1218 WARRENS WAY, WANAGUE, NJ,07465 TEL: 201-681-7777 TEL: 973-723-0039 DANONGROUP@AOL.COM

> RAFAEL DANON, R.A., REGISTERED ARCHITECT

SHEET TITLE: EXISTING PLANS

AS NOTED DRAWN BY: REVIEWED BY:

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